

**-loor Plan** 

ginia

**Fire Station #2** arrisonburg. Virgini


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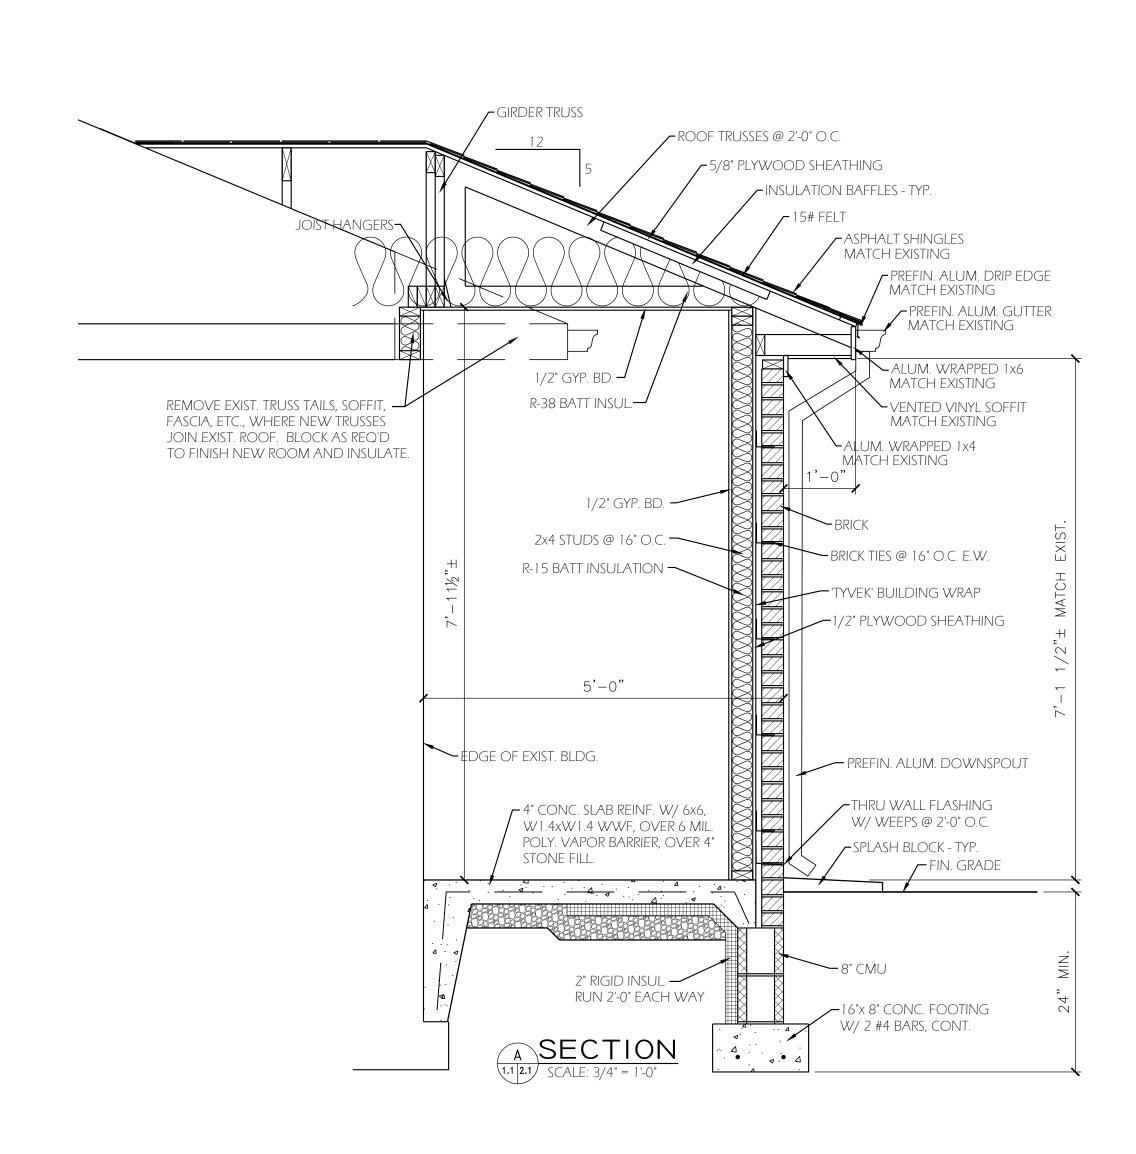
Date: 7/22/2022
Project: 022008
File: xx.dwg
Drawn By: fwr

ALI

FRONT ELEVATION

1/4" = 1'-0"



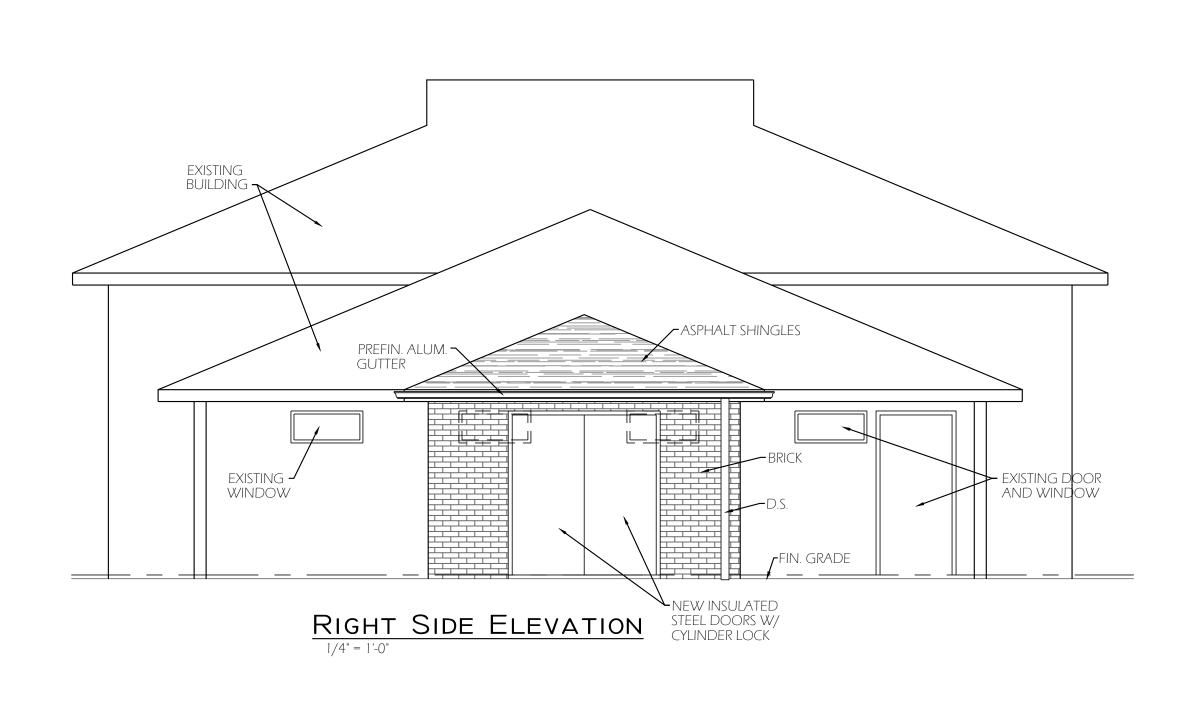

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S40-442-1400


Elevations & Section Scale: As Noted

Fire Station #2 Harrisonburg, Virginia

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A2.1



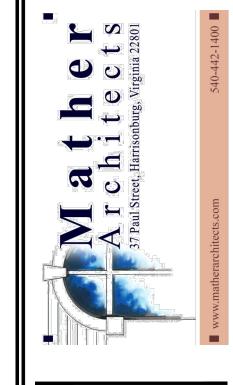

**oor Plan**le: 1/4" = 1'-0"


on #3 Virginia

**Fire Station** # Harrisonburg. Vir


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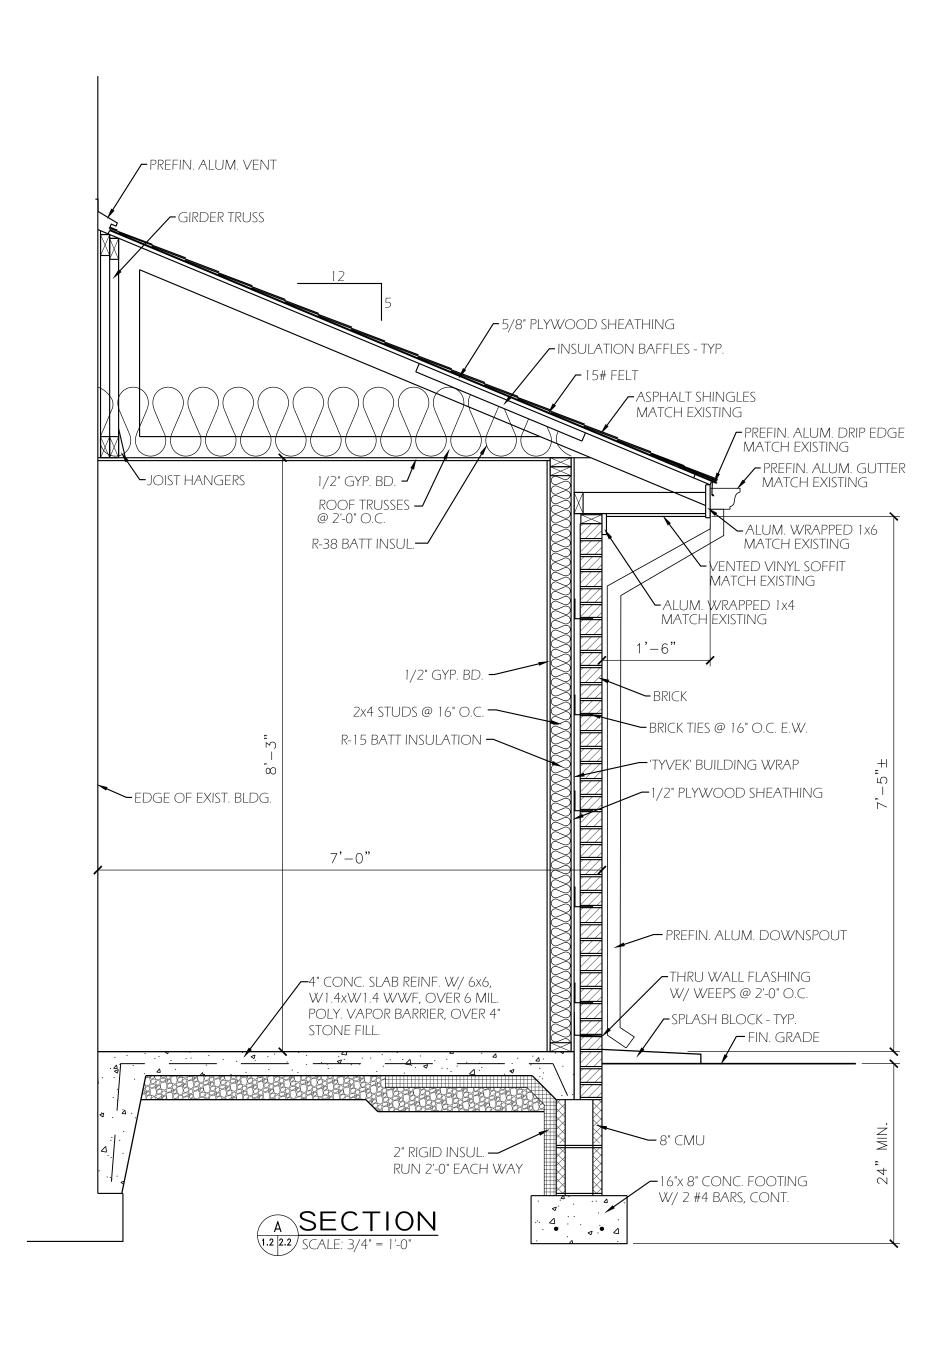
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Δ1.2



# FRONT ELEVATION 1/4" = 1'-0"

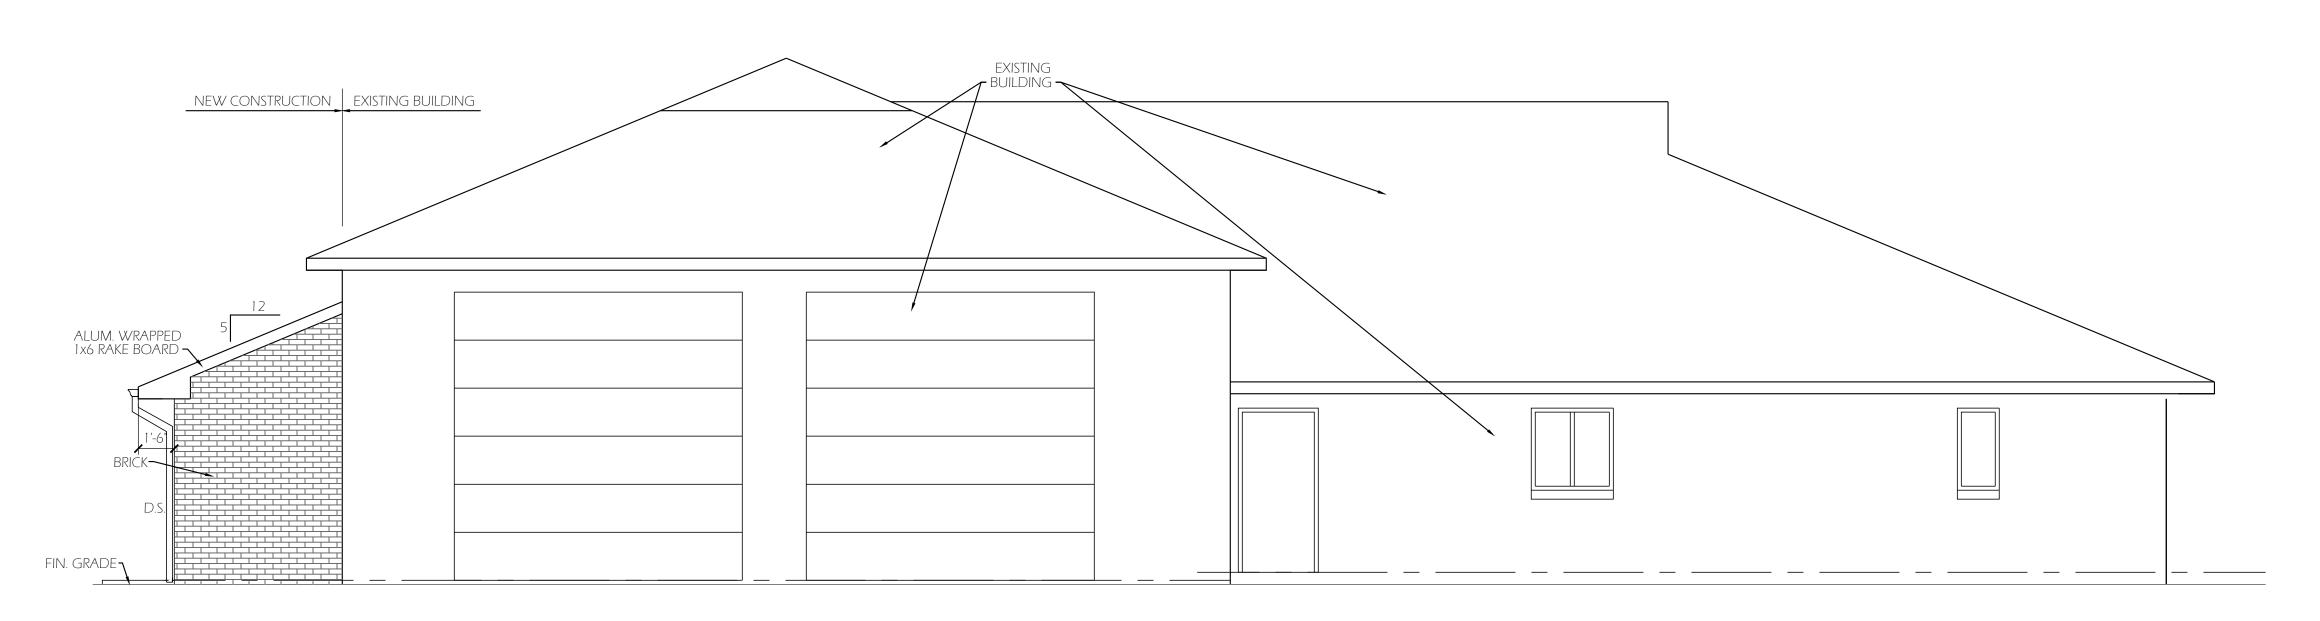

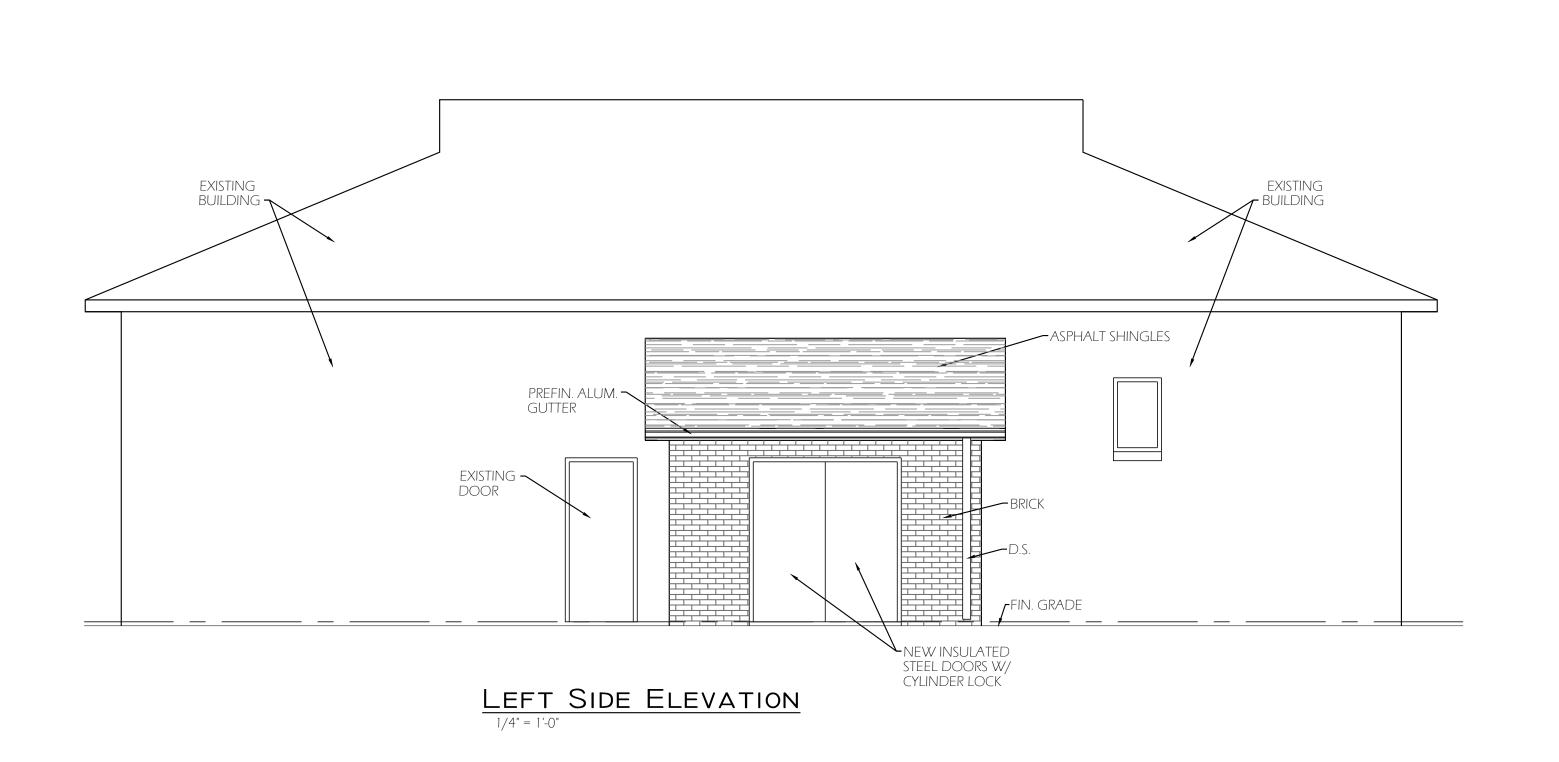

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Street, Harrisonburg, Wirginia 22801


Elevations & Section

Fire Station #3 Harrisonburg, Virginia

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A2.2



1/16" = 1'-0"

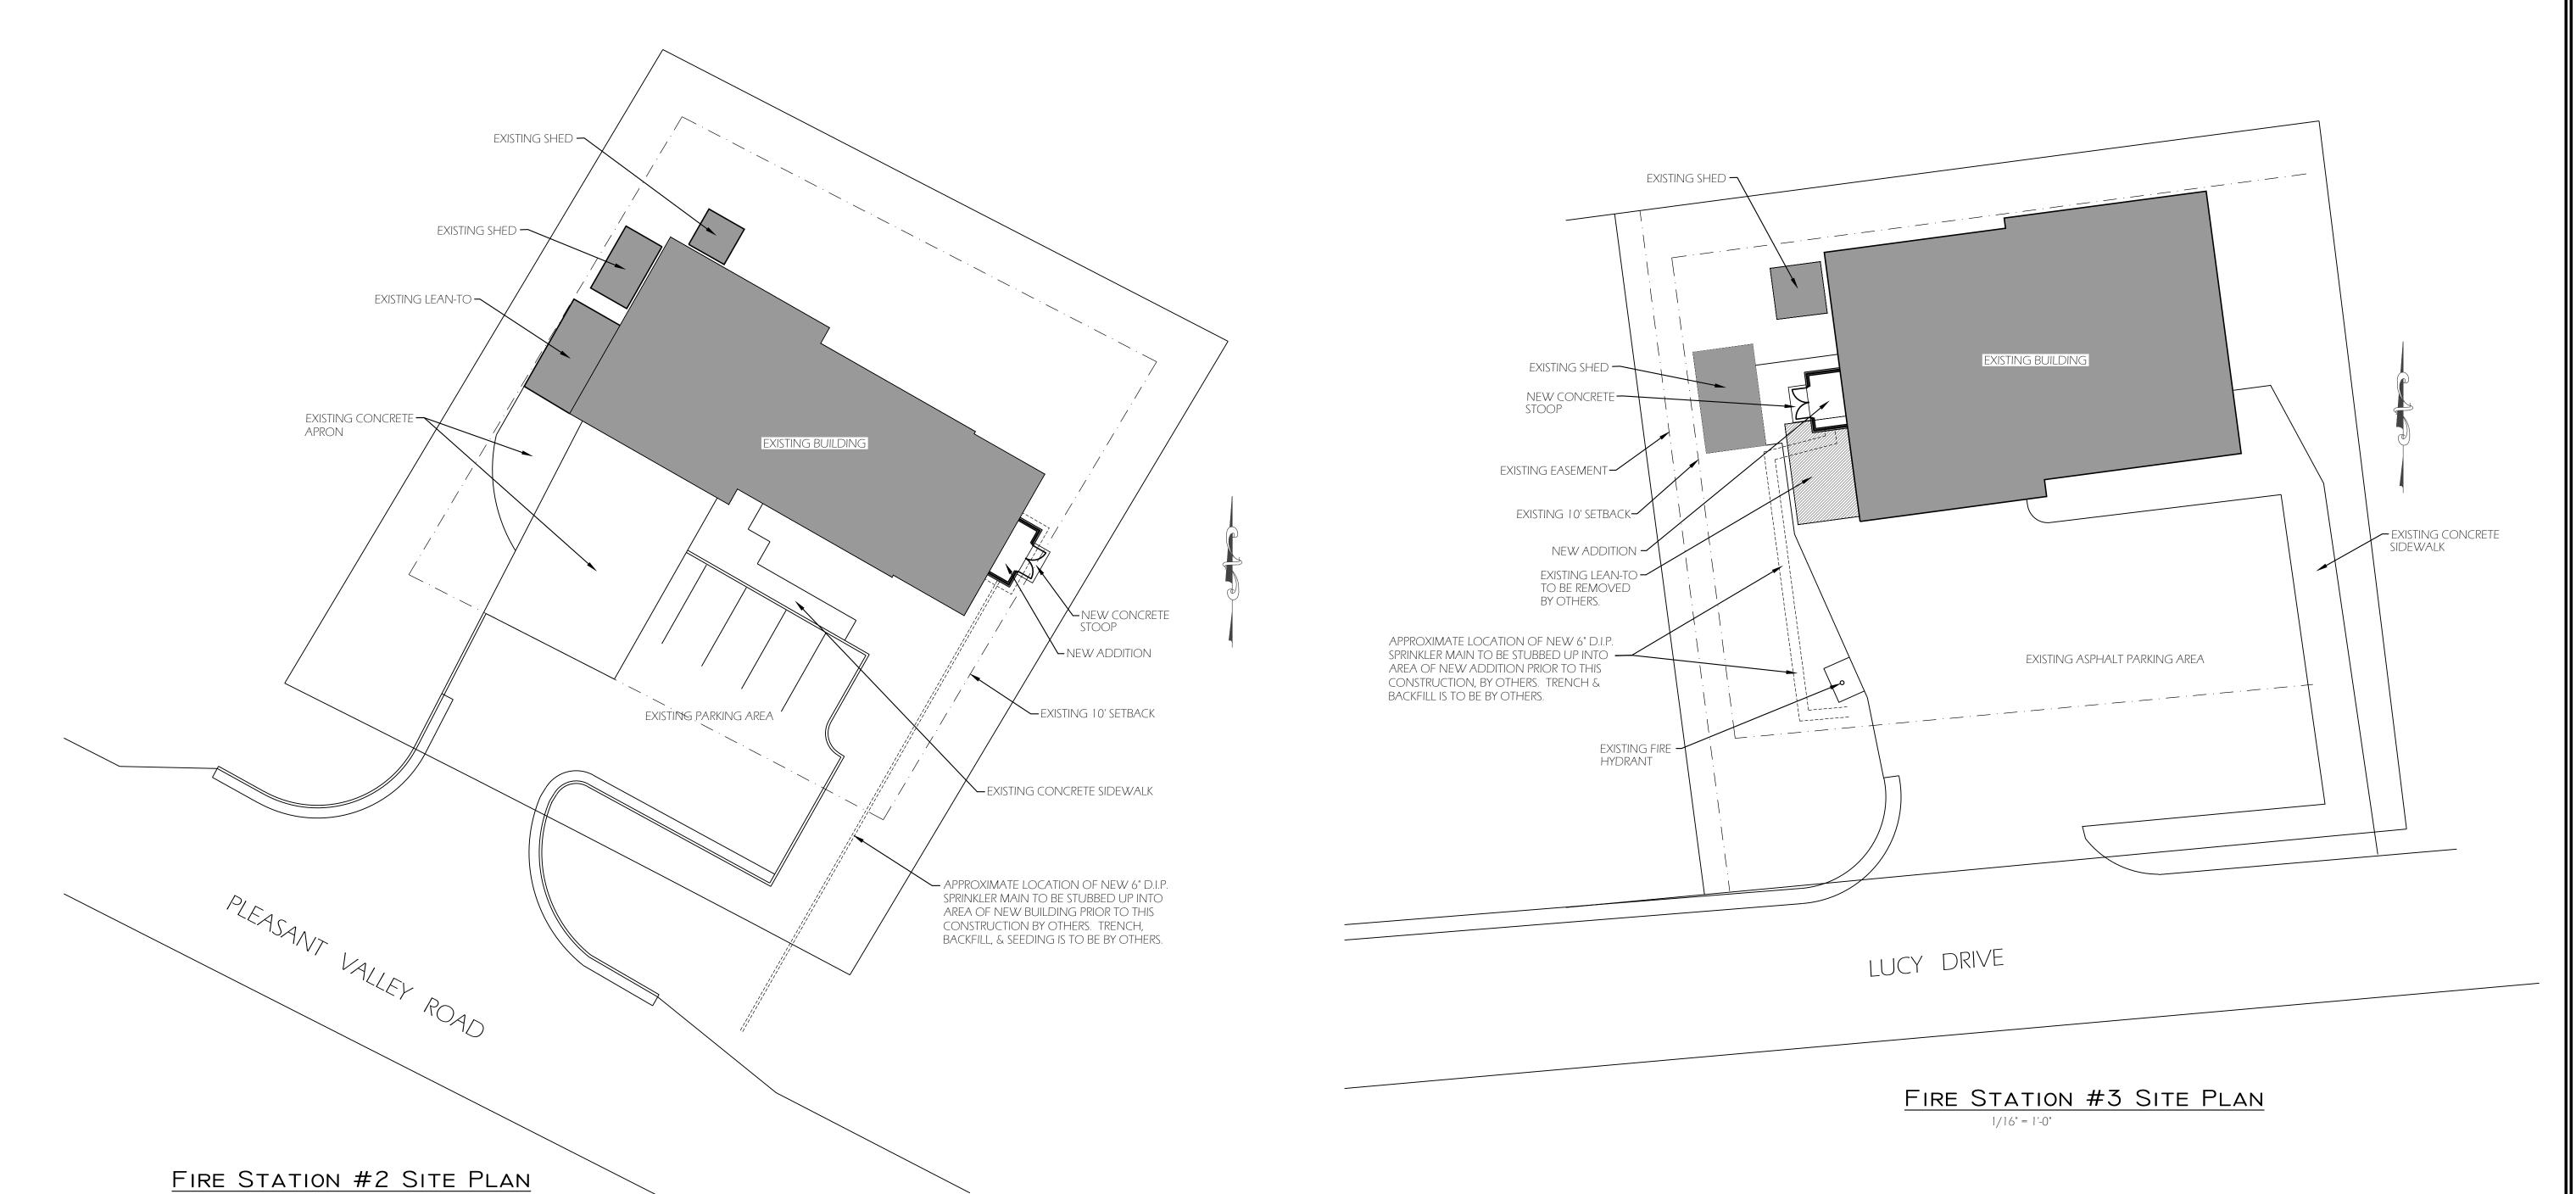Arrest Harrisonburg, Virginia 22801

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**Site Plans** ale: 1/16" = 1'-0'


Fire Stations #2 & #3 Harrisonburg, Virginia

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### ARCHITECTURAL GRAPHIC SYMBOLS INDEX



# ADDITION TO FIRE STATIONS 2 & 3

HARRISONBURG, VIRGINIA
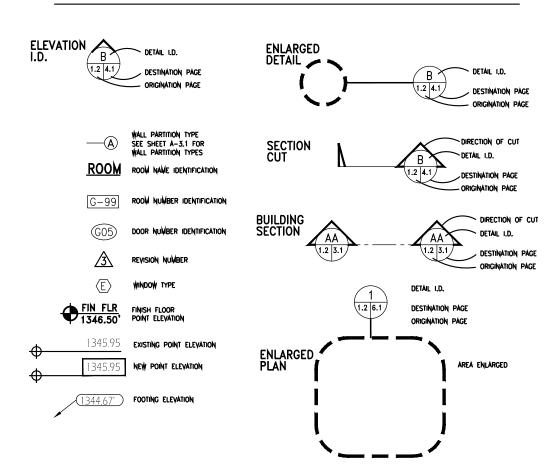
# TABLE OF CONTENTS

TITLE SHEET

STATION #3 FLOOR PLAN ELEVATIONS & SECTION

STATION #2 FLOOR PLAN ELEVATIONS & SECTION

#### CODE INFORMATION:

( 2018 Virginia Existing Building Code ) ( 2018 Virginia Construction Code )

<u>Use Group</u>: "B" Business - Unchanged

General Height and Area Limitations: 3 story, 60', 36,000 sf w/ sprinklers


Actual Area Station 3 - 4,087 sf

<u>Construction Classification</u>: 5B - No change to Existing Construction Type

Additions: Additions to any building or structure shall comply with the requirements of the VCC for new construction...

Automatic Sprinkler Systems: Not Required. NFPA 13 system provided.

ARCHITECTURAL MATERIALS LEGEND

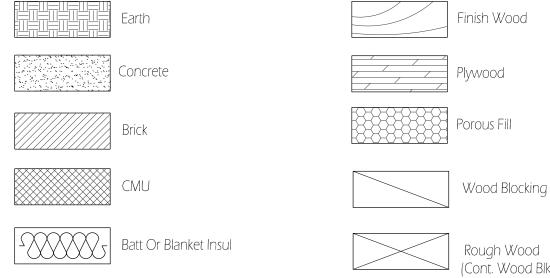

## TYPICAL ABBREVIATIONS

FLOOR FOOTING

ADA	AMERICANS WITH DISABILITIES ACT	GA.	GAUGE	PEMB	PRE-ENGINEERED METAL BUILDIN
\FF	ABOVE FINISH FLOOR	GALV.	GALVANIZED	PL.	PLATE
DJ.	ADJACENT	G.C.	GENERAL CONTRACTOR	PLYWD.	PLYWOOD
/C	AIR CONDITIONING	G.B.	GYPSUM BOARD	PVC	POLYVINYLCHLORIDE
LT.	ALTERNATE	GEN.	GENERAL	P.L.	PROPERTY LINE
LUM.	ALUMINUM			P.T.	PRESSURE TREATED
.B.	ANCHOR BOLT	HC	HANDICAP		
PPROX.	APPROXIMATE	HDW	HARDWARE	REF.	REFERENCE
RCH.	ARCHITECTURAL	HGT.	HEIGHT	R.C.P.	REINFORCED CONCRETE PIPE
		H.M.	HOLLOW METAL	REQ'D.	REQUIRED
SMT.	BASEMENT	HORIZ.	HORIZONTAL	R.A.	RETURN AIR
M	BENCHMARK				
_K.	BLOCK	I.D.	INTERIOR DIAMETER	REV.	revision, reverse
.KG.	BLOCKING	I.P.	INLET PROTECTION	R.H.	RIGHT HAND
OT.	BOTTOM	insul.	Insulation	R.O.W.	RIGHT OF WAY
DG.	BUILDING	INT.	INTERIOR	R.D.	ROOF DRAIN
?K.	BRICK	INV.	INVERT	RM.	ROOM
				R.T.	RUBBER TILE
AB.	CABINET	J.C.	Janitors closet		
В.	CATCH BASIN	JST.	JOIST	S.F.	SILT FENCE
L.	CENTER LINE			SHT.	SHEET
 _G.	CEILING	K.O.	KNOCK OUT	SH.	SHELF
ER.	CERAMIC	1		SIM.	SIMILAR
MU	CONCRETE MASONRY UNIT	LAD		S&R	SHELF & ROD
OL.	COLUMN	LAB.	LABORATORY	SPEC.	SPECIFICATION
ONC.	CONCRETE	LH	LEFT HAND	SQ.	SQUARE
ONST.	CONSTRUCTION	L.L.	LIVE LOAD	S.S.	STAINLESS STEEL
J.	CONTROL OR CONST. JOINT		NANU 101 E	S.S.	STORM SEWER
PT.	CARPET	M.H.	MANHOLE	STD.	STANDARD
T. TNC.	CONTINUOUS	MFR.	MANUFACTURER	S.D.	STORM DRAIN
S141. RS.	COURSE	M.O.	MASONRY OPENING	STL.	STEEL
	CERAMIC TILE	M.B.	MARKER BOARD	JIL.	SILLL
C.T.	CLIV WIIC TILL	MAX.	MAXIMUM	T.B.	TACKBOARD
l.	DROP INLET	MECH.	MECHANICAL	TEL.	TELEPHONE
ı. М.	DIMENSION	MED.	MEDIUM	T.V.	TELEVISION
s.	DOWNSPOUT	MIN.	MINIMUM	THK.	THICK
		MIR.	MIRROR	TYP.	TYPICAL
WG.	DRAWING	MISC.	MISCELLANEOUS	TZT	TERRAZZO TILE
		MULL.	MULLION	171	ILNN VZO IILE
 Г <i>С</i>	ELEVATION			VCT	VINYL COMPOSITION TILE
.EC.	ELECTRICAL	NIC	NOT IN CONTRACT		
DUIP.	EQUIPMENT	NTS	NOT TO SCALE	VERT.	VERTICAL
W.	EACH WAY			\ V / C	VV/ATED CLOSET
W.C.	ELECTRIC WATER COOLER	O.C.	ON CENTER	W.C.	WATER CLOSET
KIST.	EXISTING	O.D.	OVERFLOW DRAIN	WP	WATERPROOF
J.	EXPANSION JOINT	O.P.	OUTLET PROTECTION	WWF	WELDED WIRE FABRIC
J.C.	EXPANSION JOINT COVER	OPG.	OPENING	WIN.	WINDOW
EXT.	EXTERIOR	OPP.	OPPOSITE	W/O	WITHOUT
		OA.	OVERALL	WD.	WOOD
D.	FLOOR DRAIN	0.H.	OVERHEAD	W/	WITH
	EIDE EVTINICI IICHED	- · · · ·			



**Scale** 

Stations

7/22/2022